


ABBREVIATIONS Regulatory Agency Approval **IDENTIFICATION STAMP** LAKESIDE ELEMENTARY SCHOOL DIV. OF THE STATE ARCHITEC air conditioning GA. RET. retaining asphaltic concrete APP: 01-122102 INC: GALV. above finish floo revision galvanized **REVIEWED FOR ACCESS** SS 🗹 FLS 🗹 ACS 🗌 ACOUS. acoustical GND. GYP. adjustable gypsum DATE: 3/20/2025 AGG. hose bib see civil drawings aggregate EMERGENCY GENERATOR INFRASTRUCTURE aluminum hollow core soap dispenser alternate hollow metal see electrical drawings ANC. anchor heating, ventilating square foot/feet APPROX. see food service drawin approximate air conditioning 19621 BLACK ROAD, LOS GATOS, CA 95033 architect(ural) see landscape drawings hardware AUTO. HDWD. hardwood HORIZ. ABV. horizontal sanitary napkin dispen sanitary napkin receptac BTWN. slab on grade see plumbing drawings SHEET INDEX STATE AGENCY REQUIREMENTS S.S. inside diameter DSA: 01 -122102 / File: 43-25 **BLKG** blocking see structural drawings INCL. include S.Y. square yard All numbers refer to Part 1, Title 24, CCR of the 2022 CBC. TITLE & CODES BOT. PTN: 69492-3 INSUL insulation SAN. sanitary TITLE SHEET Addenda and CCD's shall be processed per section 4-338. C.B. catch basin interior schedule CODE SITE PLAN invert cast iron SECT. section Any condition encountered that is not covered by DSA approved documents FILE: 43-25 cast in place SHT. sheet shall be detailed and submitted and approved by DSA prior to execution of low point sheathing control joint DSA #: 01-122102 CAB. laboratory similar SITE PLAN LAM. CEM. cement laminate SPAC. spacing A DSA certified project Inspector employed by the District (Owner) and shall A-12.1 SITE DETAILS CER. lavatory SPEC(S) specification(s) be certified and approved by DSA. The project Inspector shall provide CLG. pound SQ. square continuous inspection of work per section 4-333(b) & 4-342 CLR. location STD. standard COL. E001 SYMBOLS, ABBREVIATIONS, GENERAL light STL. Steel Tests and testing laboratory per section 4-335 (employed by owner), shall manhole CONC. STOR CONSTRUCTION NOTES, LIGHT FIXTURE SCHEDULE be accepted by DSA and conduct all the required tests and inspections for STRUCT. CONSTR. construction structural CODES & SHEET INDEX CONT. continuous suspended McKim Design Group E101 ELECTRICAL SINGLE LINE DIAGRAM & DETAILS MAX COORD coordinate maximum SYM. SYS. symmetrical system Provide special inspection per section 4-333(c) OVERALL SITE PLAN MECH. mechanical Contractor, Inspector, Architect and Engineer shall submit verified reports E202 PARTIAL SITE PLAN MED. medium CTSK. 4595 Cherry Avenue, First Floor, San Jose, CA 95118 countersunk top and bottom ph. (408) 927-8110 fax (408) 927-8112 MEMBR per section 4-336 & 4-343(c). membrane T.C. drinking fountai top of curb MEZZ. DBL. mezzanine T&G tongue and groove Administration of construction per Part 1, Title 24, CCR manufacturer DET. T.O. a. Duties of Architect, Structural Engineer, or professional engineer per TOTAL SHEETS: 8 DIA. minimum diamete section 4-333(a) & 4-341 miscellaneous DIAG. diagonal top of sheathing MTD. DIM. mounted dimension b. Duties of contractor per section 4-343 MTL./MET DISP. metal top of pavement c. Verified reports per section 4-336 & 4-343(c) not in contract toilet paper dispenser Governing Codes: Title 24, CCR. DWG(S) T.S.C.D. toilet seat cover dispenser NO. number television A copy of Part 1 through Part 5 of Title 24 shall be kept and available in field NOM. nominal each side TEL. telephone temperature DSA shall be notified on start of construction per section 4-331 on center outside diameter elevation thick Supervision by the Division of the State Architect (DSA) per section 4-334. ELEC. electrical Separate application may be required for all N.I.C. items not part of DSA ELEV. unless otherwise noted overhead EMER OPNG. ENCL. openina enclosure vitreous clay pipe Refer to the DSA-103 form of required structural tests and special OPP. **ENGR** enginee vinyl composition tile plastic laminate P.V.C. 13. DSA is not subject to arbitration. **EQUIP** vent through roof PERF. perforated ETC. 14. Changes or revisions which affect access compliance are required to be EXP. expansior vertical submitted to DSA for approval PLBG. plumbing exterior VEST. vestibule PLYWD. Substitutions affecting DSA-regulated items shall be submitted as fire alarm plywood with floor drain water closet Construction Change Documents or Addenda and shall be approved by prefabricated fire extinguishe without DSA prior to fabrication and installation. W.P. flat head waterproof Engineer Seal face of concrete welded wire fabric quarry tile face of finish wood **GOVERNING CODES** DSA 103-22: APPENDIX WORK EXEMPT FROM DSA RQEUIREMENTS reflected ceiling plan face of stud FDN. foundation wainsco NOTE: Those items identified below with a "X" mark by the design professional are NOT subject to DSA requirements for the structural tests / special inspections noted on the DSA 103-22. roof drain overflow FIN. 2022 California Administrative Code (CAC), Part 1, Title 24 C.C.R FLR. rough opening 2022 California Building Code (CBC), Part 2, Title 24, C.C.R. R.W.L CONCRETE / MASONRY RAD. radius X 2. Concrete batch plant inspection foot or feet 2022 California Electrical Code (CEC), Part 3, Title 24, C.C.R. FTG. REF. footing 2022 California Mechanical Code (CMC), Part 4, Title 24, C.C.R. REFL. reflected FUR. furring 2022 California Plumbing Code (CPC), Part 5, Title 24, C.C.R. REFR. refrigerator G.B. grab bar REINF. reinforce(d) (ing),(ment) general contractor 2022 California Energy Code (CEC), Part 6, Title 24, C.C.R. REQ'D. galvanized iron 2022 California Fire Code (CFC), Part 9, Title 24, C.C.R. APPLICABLE NFPA STANDARDS 2022 California Existing Building Code (CEBC), Part 10, Title 24 C.C.R. 2022 California Green Building Standards Code (CALGreen), Part 11, Title 24 C.C.R. NFPA 13 - Standard for the Installation of Sprinkler Systems (CA amended). .2022 Edition 2022 California Referenced Standards Code, Part 12, Title 24, C.C.R. NFPA 14 - Standard for the Installation of Standpipe and Hose Systems (CA amended)....2019 Edition Title 19 CCR, Public Safety, State Fire Marshal Regulations NFPA 17 - Standard for Dry Chemical Extinguishing Systems.. .2021 Edition No. C-25022 NFPA 17A - Standard for Wet Chemical Extinguishing Systems.. .2021 Edition REN. 4-30-25 2010 ADA Standards for accessible design NFPA 20 - Standard for the Installation of Stationary Pumps for Fire Protection... ..2019 Edition **GENERAL CONSTRUCTION NOTES** PROJECT SUMMARY PROJECT DIRECTORY .2013 Edition NFPA 22 - Standard for Water Tanks for Private Fire Protection... NFPA 24 - Standard for the Installation of Private Fire Service Mains and Their Appurtenances STATEMENT OF GENERAL CONFORMANCE Project includes the installation of electrical equipment, conduit and wiring to (CA amended)... .2019 Edition All work shall be performed in conformance with local, county, state and federal Lakeside Joint School District ph. (408) 354-2372 Project Title be able to connect to a portable generator. The portable generator will provide codes, laws, and regulations applicable to this work, including CCR Title 19, 19621 Black Road NFPA 37 - Installation and Use of Stationary Combustion Engines and Gas Turbines...2018 Edition temporary power to the site during emergencies. Los Gatos, CA 95033 NFPA 72 - National Fire Alarm and Signaling Code (CA amended). .2022 Edition FOR ARCHITECTS/ENGINEERS WHO UTILIZE PLANS, LAKESIDE NFPA 80 - Standard for Fire Doors and Other Opening Protectives. .2019 Edition Existing construction data shown on the drawings was obtained from available INCLUDING BUT NOT LIMITED TO SHOP DRAWINGS, PREPARED BY OTHER ARCHITECT McKim Design Group ph. (408) 927-8110 drawings. The contractor shall verify all existing conditions and shall notify the NFPA 2001 - Standard on Clean Agent Fire Extinguishing Systems (CA amended)... ...2018 Edition **ELEMENTARY SCHOOL** LICENSED DESIGN PROFESSIONALS AND/OR CONSULTANTS 4595 Cherry Ave. 1st Floor UL 300 - Standard for Fire Testing of Fire Extinguishing Systems for Protection of Commercial Cooking architect of all exceptions before proceeding with the work. DEFERRED APPROVALS San Jose, CA 95118 (Application No. 01-122102 File No. 43-25) .2005 (R2010) All discrepancies between drawings shall be clarified with the architect prior to 19621 Black Road Kirk S. McKim, Architect UL 464 - Audible Signaling Devices for Fire Alarm and Signaling Systems, Including Accessories proceeding with the work. None Los Gatos, CA 95033 ..2003 Edition X The drawings or sheets listed on the cover or index sheet (Electrical) In the event that certain features of the construction are not fully shown or ELECTRICAL Aurum Consulting Engineers ph. (408) 564-7925 UL 521 - Standard for Heat Detectors for Fire Protective Signaling Systems. .1999 Edition detailed on the drawings or called for in the general notes, then their This drawing, page of specifications/calculations 1798 Technology Drive, Suite 242 EMERGENCY GENERATOR UL 1971 - Standard for Signaling Devices for the Hearing Impaired... ..2002 (R2010) construction shall be of the same character as similar conditions shown or San Jose, CA 95110 **ALTERNATES** ICC 300 - Standard for Bleachers, Folding and Telescopic Seating, and Grandstands.......2017 Edition have been prepared by other design professionals or consultants who are licensed and/or Najib Anwary, Senior Project Manager INFRASTRUCTURE Verify electrical, mechanical, fire alarm, telephone and security requirements authorized to prepare such drawings in this state. It has been examined by me for: LEGEND before construction begins. Any item identified to be demolished, removed, or relocated is to be completely) Design intent and appears to meet the appropriate requirements of Title 24, California Code removed, including but not limited to any concealed items (pipes, curbs, of Regulations and the project specifications prepared by me, and FLOOD HAZARD ZONE LAKESIDE JOINT framing, beams, fasteners, etc.). All items within a demolished area that must 2) Coordination with my plans and specifications and is acceptable for incorporation into the SCHOOL DISTRICT be rerouted in order to maintain continuity shall be done so in accordance with North Arrow <u>→ 5'-2"</u> Dimension Type 2 construction of this project. 19621 Black Road NOTE: THIS PROJECT WILL NOT No, Zone D appropriate specification sections in the project manual at no additional cost. If "N" shows Project North Face of finish - clear dimension Los Gatos, CA 95033 INCLUDE AN APPLICATION FOR no specification can be found within the project manual, then continuity shall be Arrow is True North The Statement of General Conformance "shall not be construed as relieving me of my rights, FUNDING THROUGH THE CalSHAPE Revisions/Submissions maintained by current standard methods for construction but not lesser in duties, and responsibilities under Sections 17302 and 81138 of the Education Code and FIRE ZONE PROGRAM. +98.22 New Finish Grade quality then existing. Any area of demolition or removal shall be left in a Sections 4-336, 4-341 and 4-344" of Title 24, Part 1. (Title 24, Part 1, Section 4-316 [b]) DSA Submittal V1 12/11/2024 **Shown Horizontally** completely finished condition as outlined in the project manual. Section identification Contractor to coordinate with District prior to beginning work. DSA Submittal V2 3/11/2025 Sheet where detail is I find that ALL consultant drawings or sheets listed on the cover or index sheet: The intent of these drawings and specifications is that the work of the alteration, Existing Grade rehabilitation or reconstruction is to be in accordance with Title 24, California Shown at 45 Degrees VICINITY MAP Code of Regulations. Should any existing conditions such as deterioration or X is/are in general conformance with the project design, and Section Cut non-complying construction be discovered which is not covered by the contract Section identification Reference Point documents wherein the finished work will not comply with Title 24, California \underline{X} has/have been coordinated with the project plans and specifications. Sheet where section is Drawing Title Control Point Code of Regulations, a CCD, or a separate set of plans and specifications, Datum Point detailing and specifying the required repair work shall be submitted to and approved by DSA before proceeding with the repair work. Elevation 12.11.2024 Compliance with CFC Chapter 33, fire safety during construction and demolition Section Identification Revision inside cloud and CBC Chapter 33, safety during construction will be enforced. Sheet where elevations TITLE SHEET Revision number shown 10. Contractor shall review all T-24 Energy Compliance documents and provide all are found inside triangle requirements of these documents. Contractor shall provide documentation that Shading indicates Architect or Engineer designated to be in general responsible charge all requirements were implemented at the completion of the project. direction of elevation Where CalGreen is noted and required as part of the project the contractor shall Room Identification Kirk McKim provide all requirements of these documents and shall provide documentation (D04.2) Door Callout CLASSROOM. that all requirements were implemented at the completion of the project. Project No. - Room Name Print Name 12. Per CBC 11B-104.1, all dimensions are subject to conventional industry October 10, 2024 - Ceiling height from tolerances except where the requirement is stated as a range with specific Window Callout $\langle D04.D \rangle$ Finished Floor C-25022 4/30/25 minimum and maximum end points. **Drawing Number** Location of interior elevations (detail & sheet number) Dimension Type License Number **Expiration Date** A-0.1- Room number Face of framing

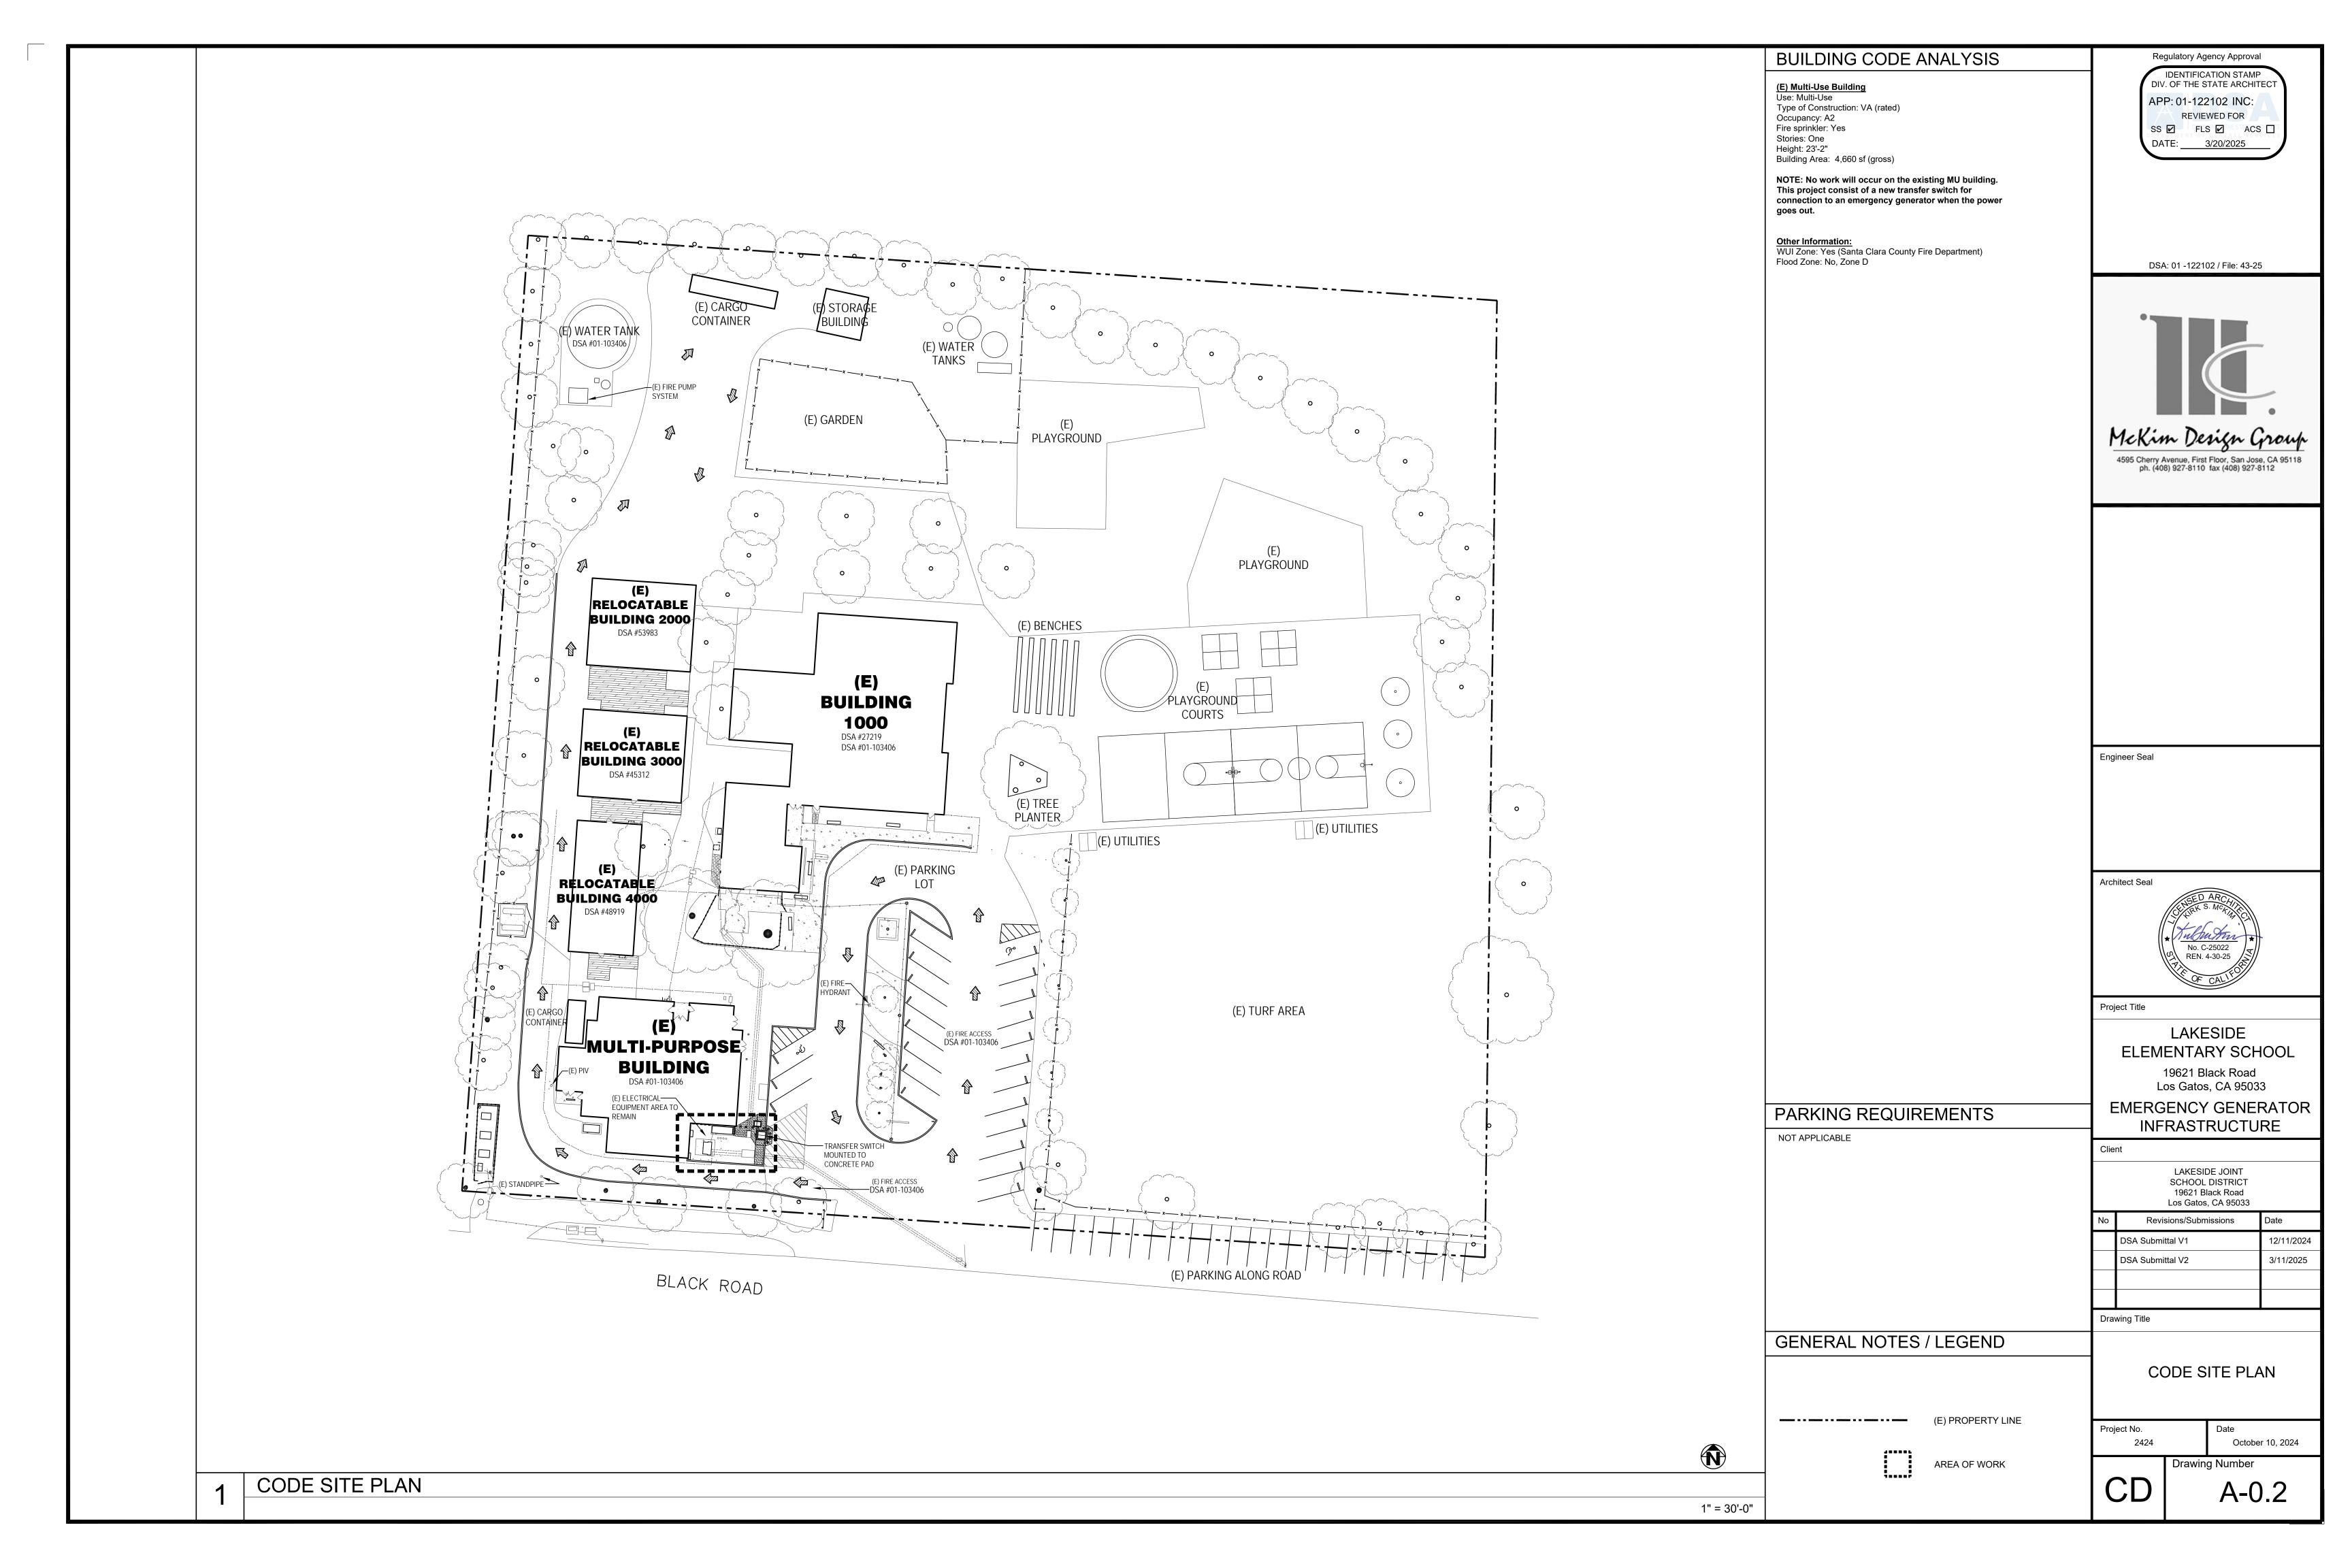

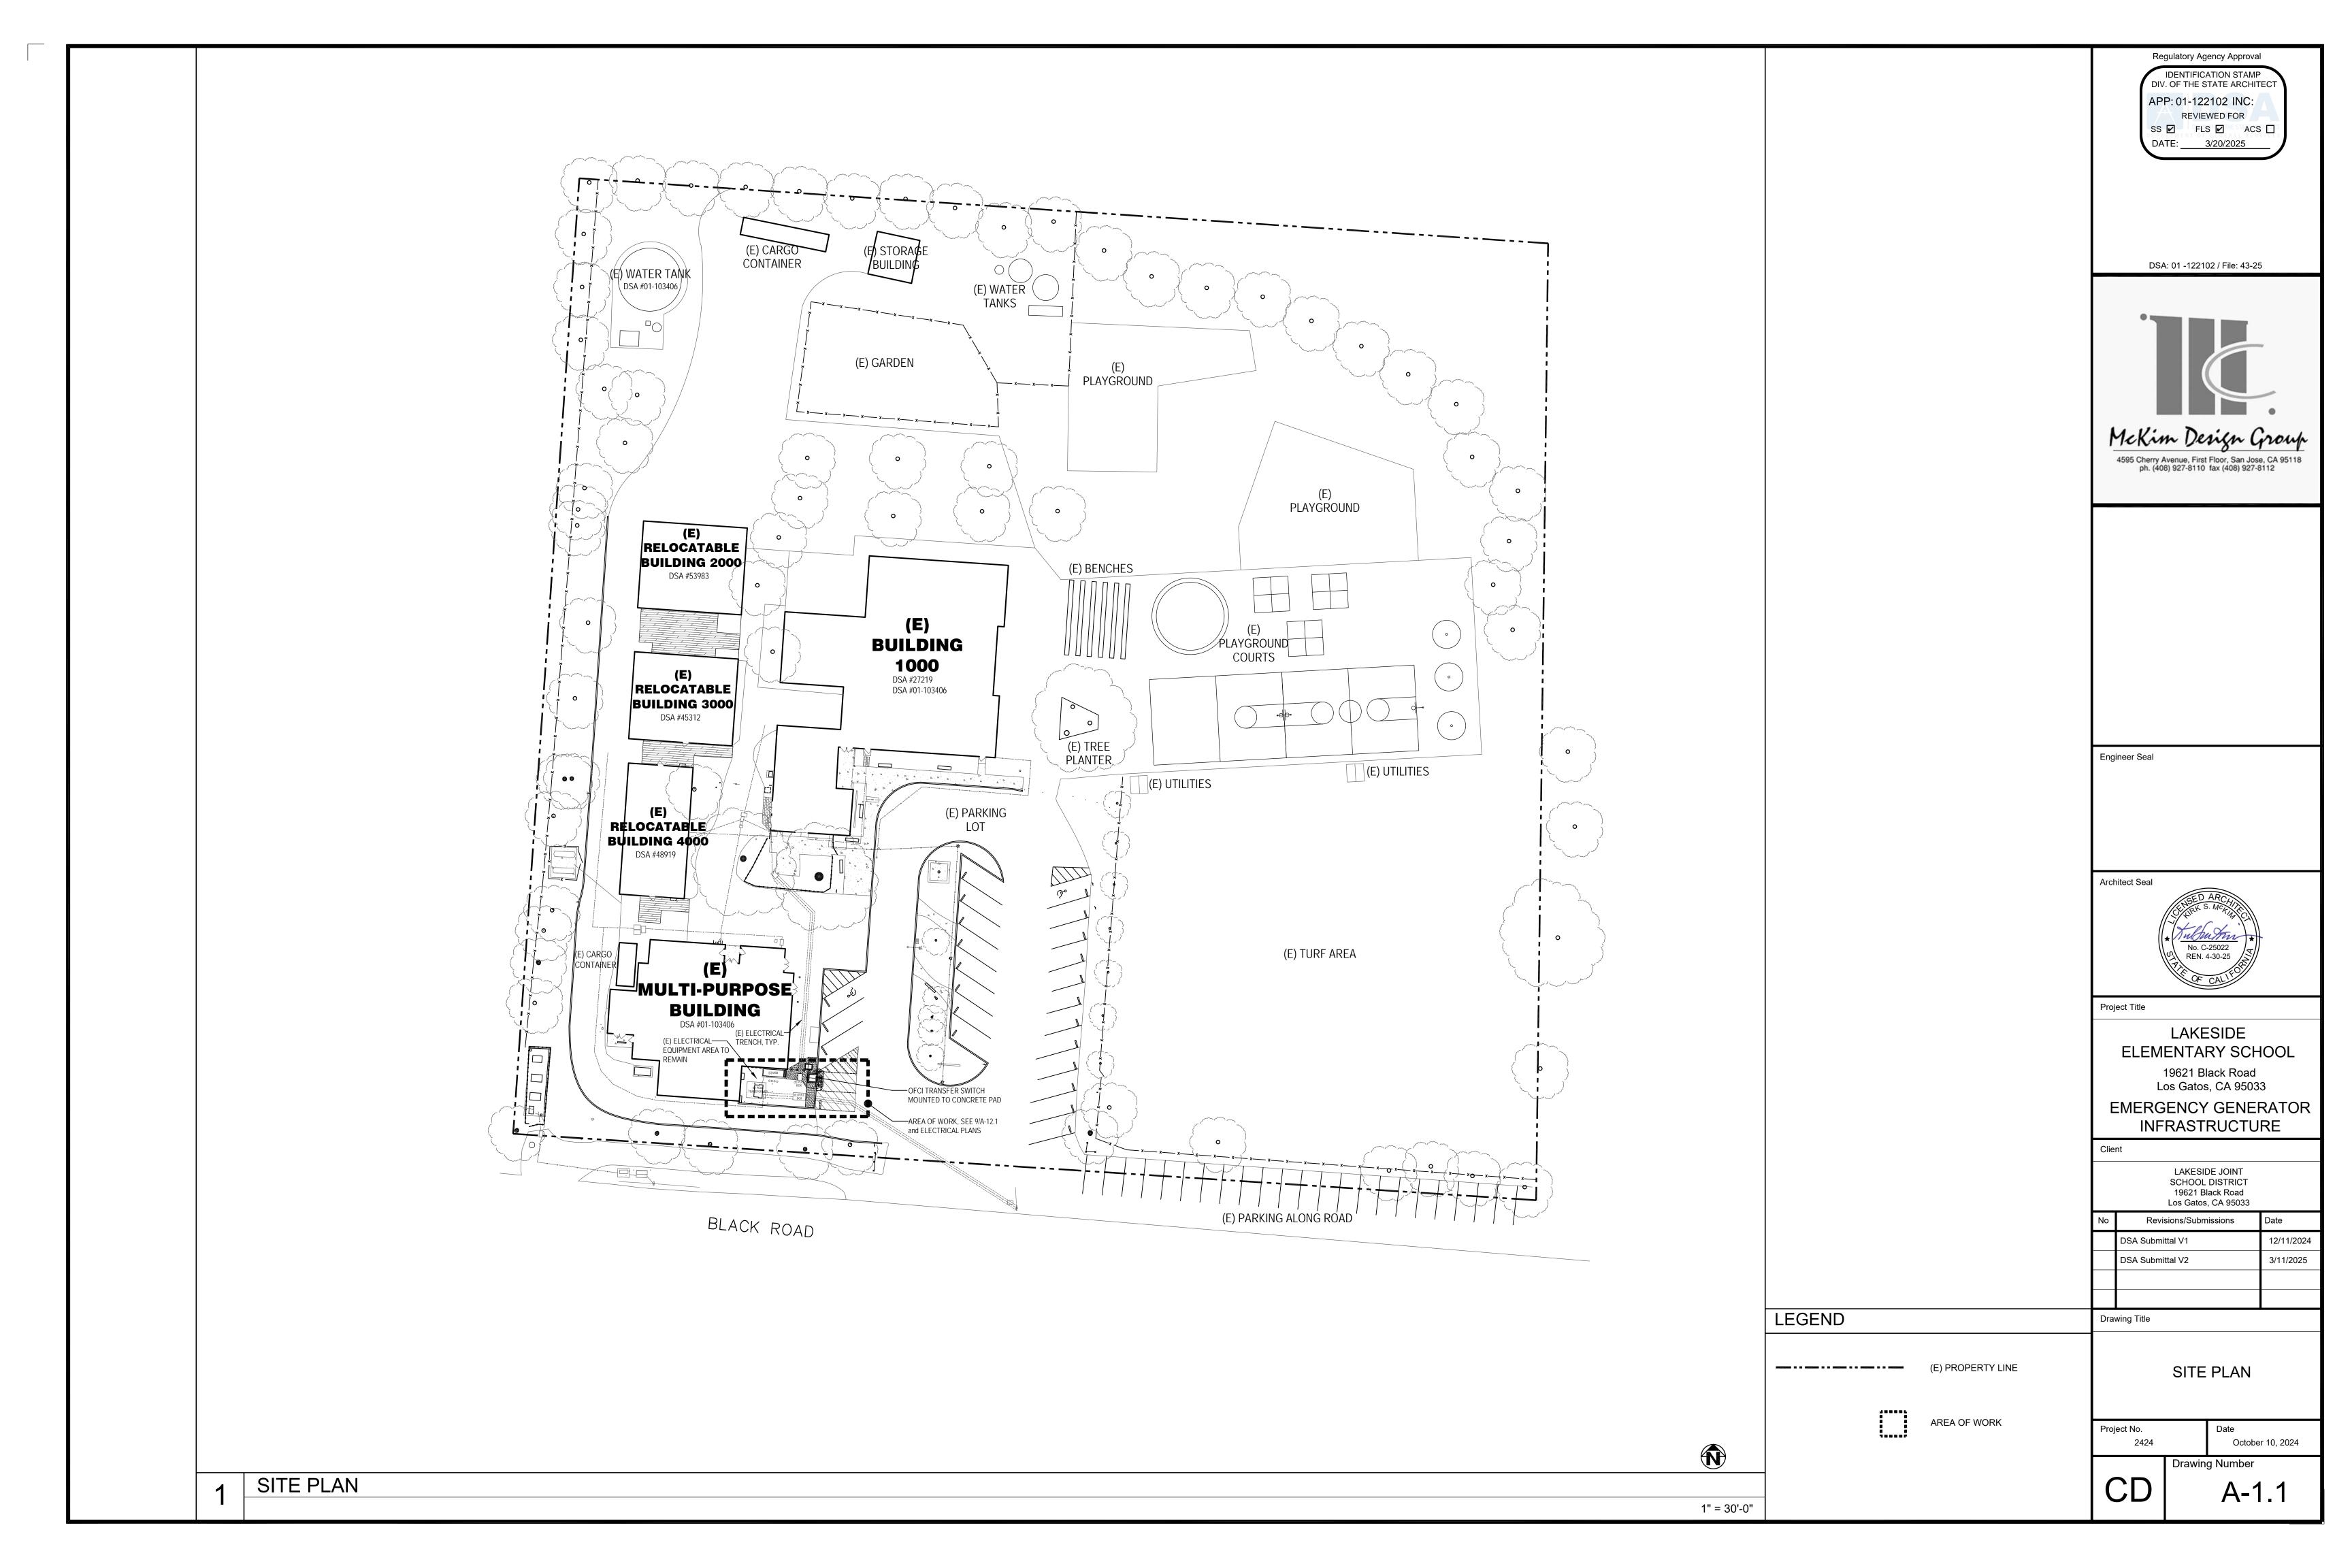

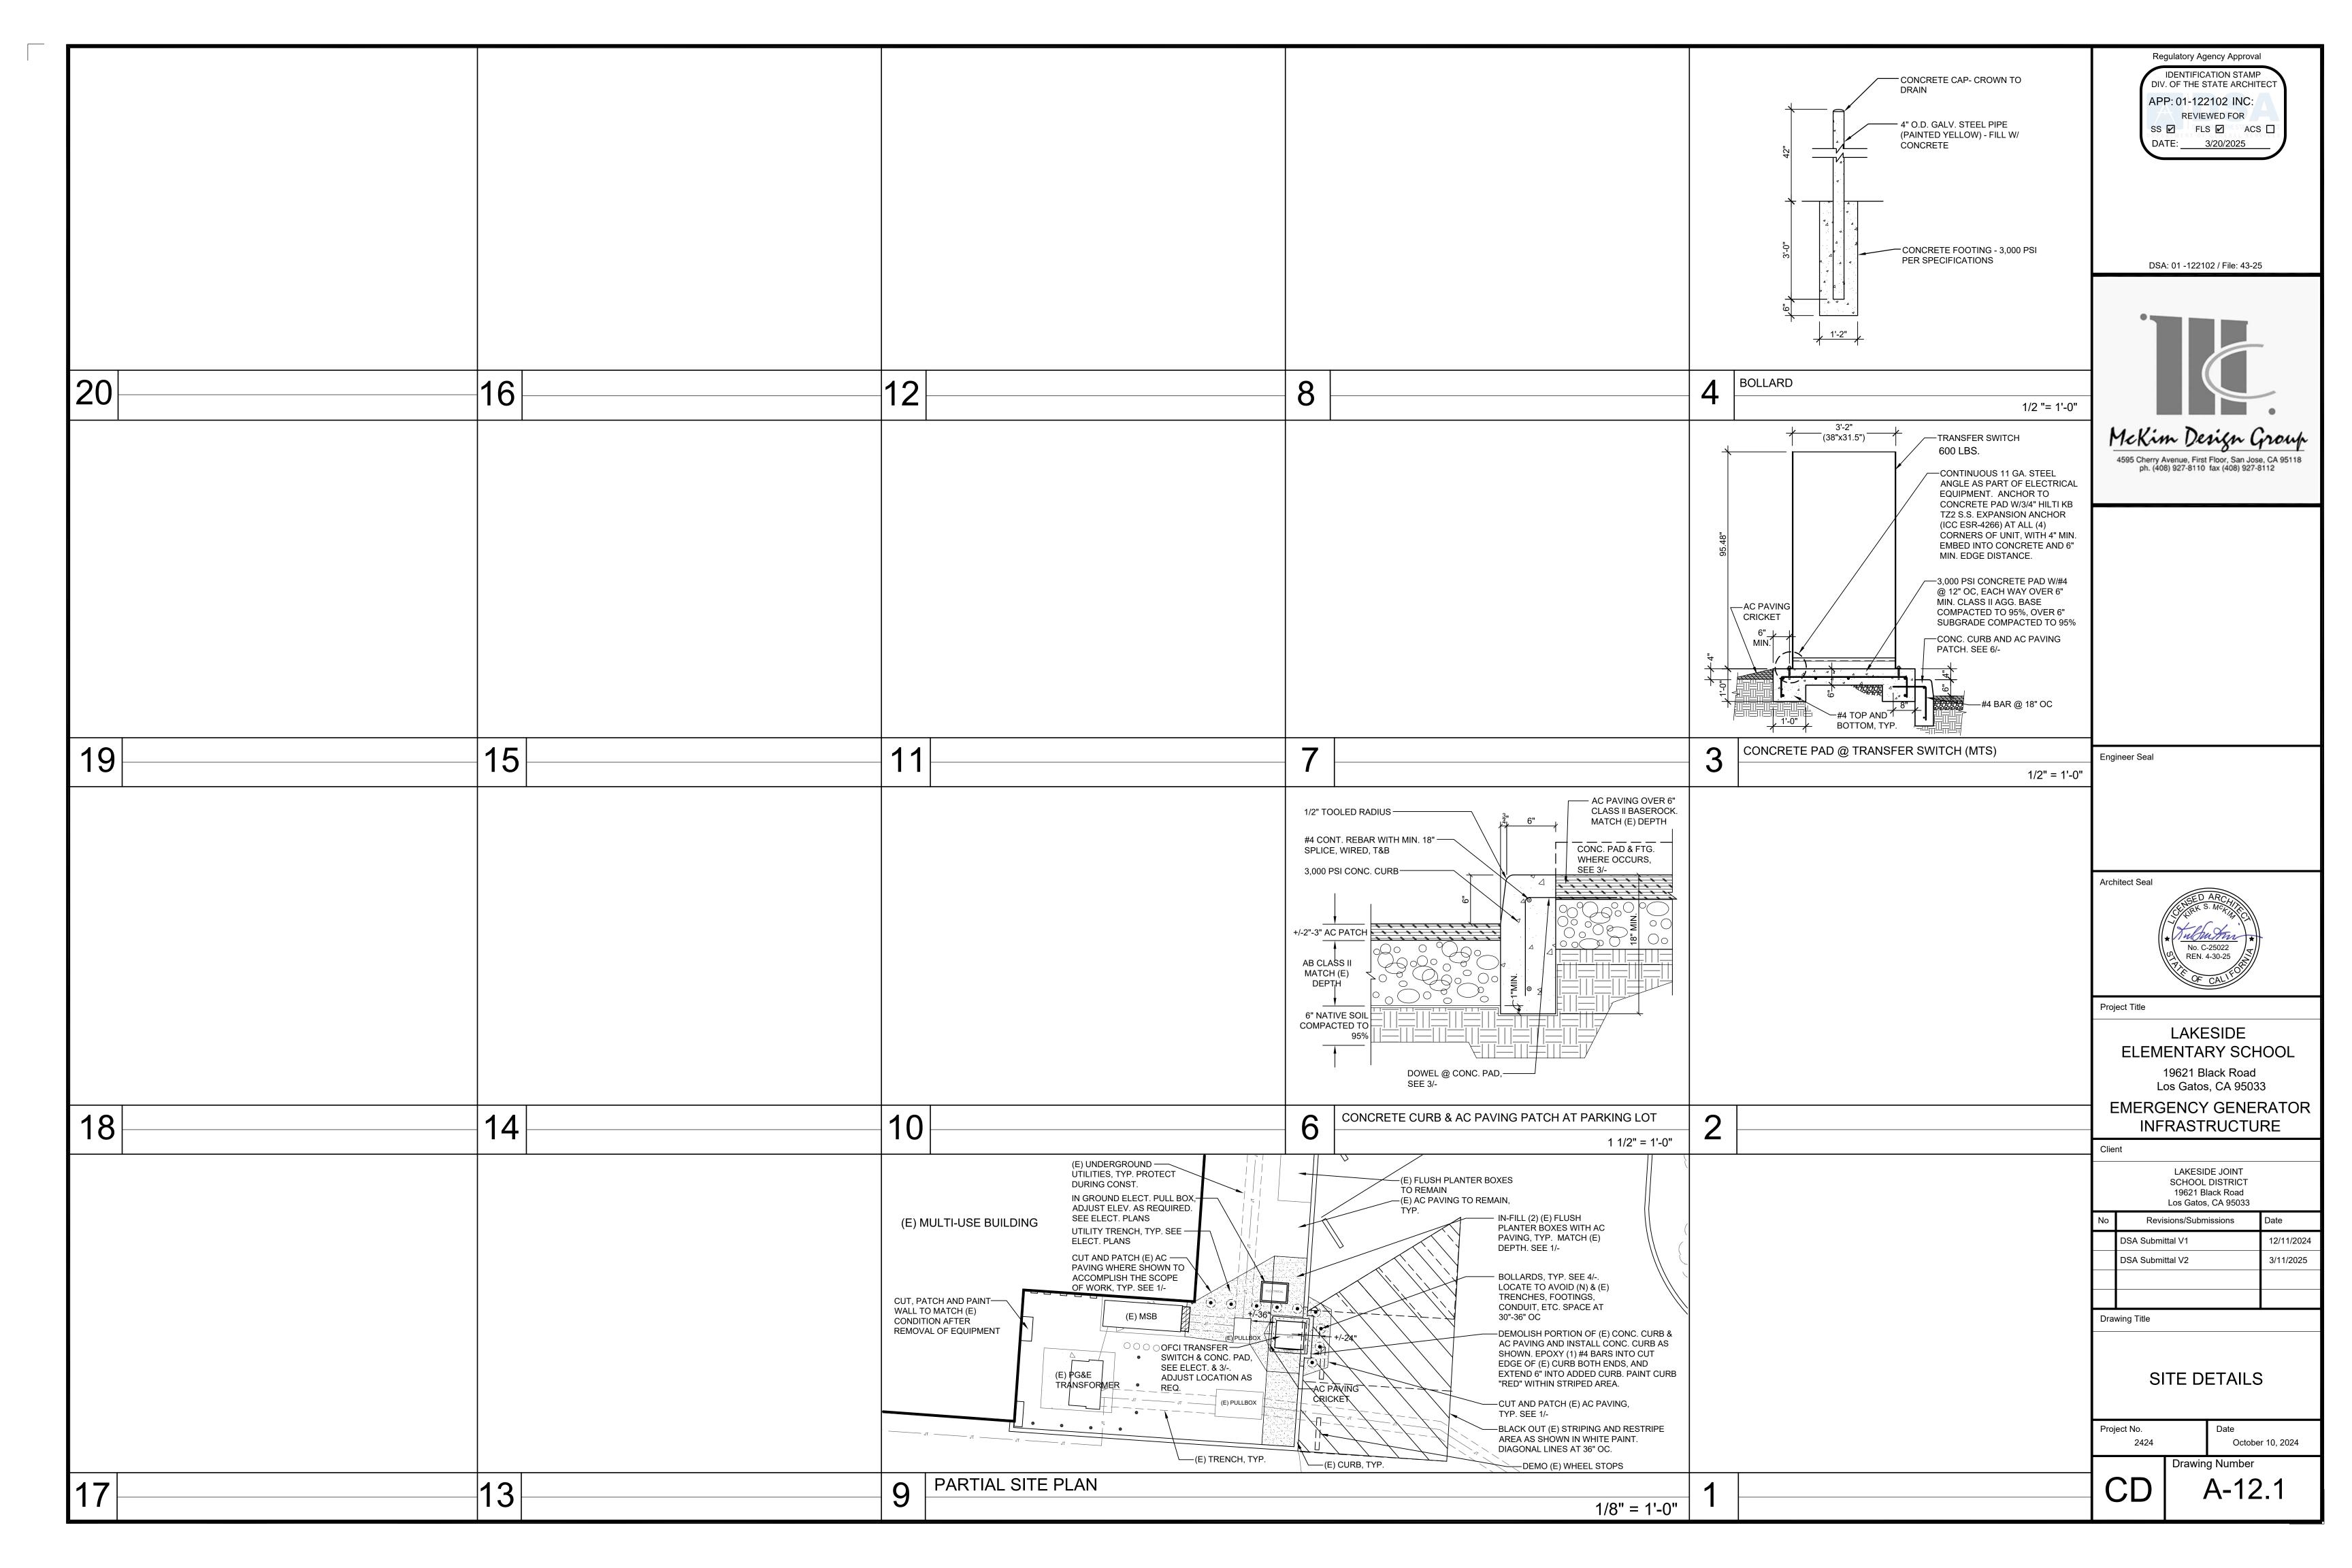

GENERAL CONSTRUCTION NOTES

CONTRACTOR SHALL COMPLY WITH ALL APPLICABLE CODES AND REGULATIONS. MATERIALS AND EQUIPMENT SHALL BE U.L. LISTED AND LABELED FOR THE APPLICATION.

- 2. THE CONTRACTOR SHALL OBTAIN AND PAY FOR ALL PERMITS, LICENSES AND INSPECTION FEES REQUIRED BY THIS CONTRACT WORK.
- CONTRACTOR SHALL VISIT THE PROJECT SITE PRIOR TO BIDDING AND ALLOW FOR ALL FIELD CONDITIONS THE CONTRACTOR SHALL BE RESPONSIBLE FOR ALL ELECTRICAL WORK NOTED AND CALLED OUT ON ALL CONTRACT DOCUMENTS. THE CONTRACTOR SHALL OBTAIN INFORMATION AND BE FAMILIAR WITH ALL OTHER TRADES WORK. THE CONTRACTOR SHALL BE RESPONSIBLE FOR COORDINATION BETWEEN OTHER TRADES ON PROJECT.
- 4. CONTRACTOR SHALL BE RESPONSIBLE FOR THE SAFETY OF PERSONS AND PROPERTY AND SHALL PROVIDE INSURANCE COVERAGE AS NECESSARY FOR LIABILITY AND PERSONAL, PROPERTY DAMAGE, TO FULLY PROTECT THE OWNER, ARCHITECT AND ENGINEER FROM ANY AND ALL CLAIMS RESULTING FROM THIS WORK.
- CONTRACTOR SHALL MAINTAIN RECORD DRAWINGS AT THE PROJECT SITE INDICATING ALL MODIFICATIONS TO ELECTRICAL SYSTEMS. THE CONTRACTOR SHALL AT THE CONCLUSION OF THE PROJECT PROVIDE ACCURATE "AS-BUILT" DRAWINGS ACCEPTABLE TO THE ARCHITECT
- 6. ALL MATERIALS PROVIDED TO THE PROJECT SHALL BE NEW. THE CONTRACTOR SHALL BE RESPONSIBLE TO PROVIDE AND INSTALL ALL INCIDENTAL MATERIALS REQUIRED FOR A COMPLETE INSTALLATION.
- CONTRACTOR SHALL PROVIDE TO THE ARCHITECT A CONSTRUCTION SCHEDULE OF ELECTRICAL WORK. THE CONSTRUCTION SCHEDULE SHALL IDENTIFY ALL SIGNIFICANT MILESTONES WITH COMPLETION DATES.
- CONTRACTOR SHALL PROVIDE ALL REQUIRED "CUTTING, PATCHING, EXCAVATION, BACKFILL AND REPAIRS" NECESSARY TO RESTORE DAMAGED SURFACES TO EQUAL OR BETTER THAN ORIGINAL CONDITIONS EXISTING AT START OF WORK.
- CONTRACTOR SHALL BE RESPONSIBLE FOR PAINTING ALL EXPOSED CONDUITS AND ELECTRICAL EQUIPMENT. REFER TO ARCHITECTS PAINTING SECTION FOR REQUIREMENTS.
- 10. ALL ELECTRICAL EQUIPMENT INSTALLED OUTDOORS SHALL BE WEATHERPROOF. EXTERIOR CONDUITS RUN INTO BUILDINGS SHALL BE INSTALLED WITH FLASHING, CAULKED AND SEALED. CONDUITS FOR EXTERIOR ELECTRICAL DEVICES SHALL BE RUN INSIDE BUILDING UNLESS OTHERWISE NOTED ON DRAWINGS.
- 11. ALL CONDUITS UNLESS OTHERWISE NOTED ON DRAWINGS SHALL HAVE AS A MINIMUM: TWO (2) #12s WITH ONE (1) #12 GROUND. "TICK" MARKS SHOWN ON CIRCUITRY ARE FOR ROUGH ESTIMATING ONLY. THE CONTRACTOR SHALL BE RESPONSIBLE FOR ALL WIRES AND WIRE SIZES REQUIRED BY LATEST CODE.
- 12. ALL BRANCH CIRCUITS SHALL HAVE INDIVIDUAL NEUTRALS. SHARED NEUTRALS ON MULTIWIRE CIRCUITS IS NOT ALLOWED.
- 13. COORDINATE ALL CONDUIT RUNS, ELECTRICAL EQUIPMENT AND PANELS WITH ALL OTHER WORK TO AVOID CONFLICTS.
- 14. SEE ARCHITECTURAL DOCUMENTS FOR EXACT PLACEMENT OF EQUIPMENT AND DEVICES.
- 15. CONTRACTOR SHALL BE RESPONSIBLE FOR ALL DAMAGE TO EXISTING UNDERGROUND SYSTEMS (GAS, WATER, TELEPHONE, ELECTRICAL, SEWER, ETC.). THE CONTRACTOR SHALL REPAIR & PAY ALL EXPENSES FOR DAMAGE TO EXISTING UNDERGROUND SYSTEMS AS A RESULT OF NEW WORK. REPAIR TO DAMAGED UNDERGROUND SYSTEMS SHALL BE TO THE OWNERS SATISFACTION WITHOUT EXTRA EXPENSE TO THE
- 16. CONTRACTOR SHALL COORDINATE WITH UTILITY COMPANIES AND FOR SHUT DOWN OF ELECTRICAL SERVICE DURING CONSTRUCTION; COORDINATE DOWN-TOWN WITH UTILITY COMPANY, DISTRICT REPRESENTATIVE AND ARCHITECT. ENSURE MINIMAL DOWN-TIME/WEEKEND OR HOLIDAY WHERE APPLICABLE SHALL BE ACCOUNTED FOR

ELECTRICAL SYMBOLS & ABBREVIATIONS

SYMBOLS & ABBREVIATIONS SHOWN ARE FOR GENERAL USE. DISREGARD THOSE WHICH DO NOT APPEAR ON THE PLANS.

PANELBOARD - FLUSH MOUNTED

EQUIPMENT PANEL - FLUSH MOUNTED

EQUIPMENT PANEL - SURFACE MOUNTED

JUNCTION BOX - CEILING OR WALL MOUNTED,

PANELBOARD - SURFACE MOUNTED

METER W/ CURRENT TRANSFORMER

SIZE PER CODE, TAPE AND TAG WIRES

FUSED DISCONNECT SWITCH; FUSED WITH

PER EQUIPMENT MFGRS NAMEPLATE DATA

GROUND ROD WITH GROUNDWELL BOX

MAGNETIC STARTER - NEMA SIZE INDICATED

DUAL-ELEMENT FUSES SIZED PER EQUIPMENT

COMBINATION STARTER/FUSED DISCONNECT SWITCH;

FUSED DISCONNECT SWITCH ELEMENT FUSES SIZED

NEMA 3R ENCLOSURE UNLESS OTHERWISE SPECIFIED


NON-FUSED DISCONNECT SWITCH

MOTOR CONNECTION

MFGR'S NAMEPLATE DATA

CIRCUIT BREAKER

GROUND ELECTRODE

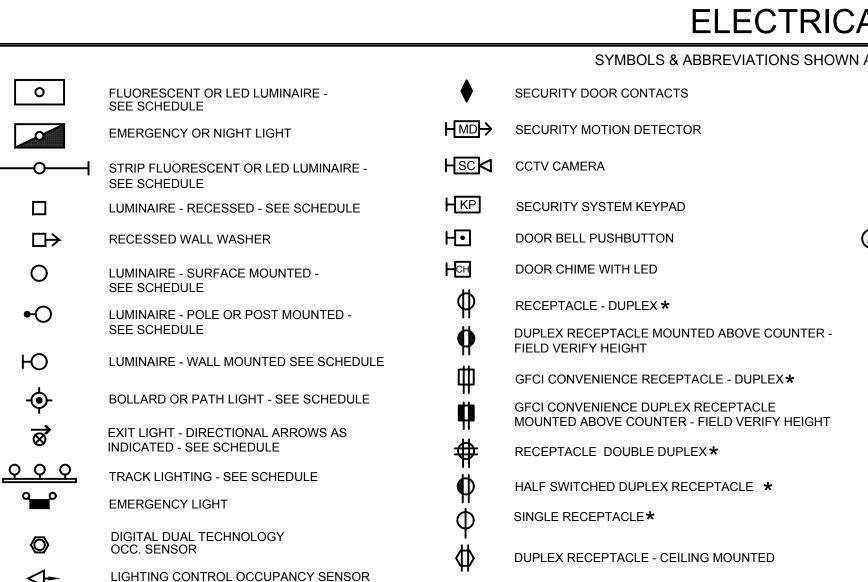

LETTER INDICATES DUPLEX HALF

CONTROLLED RECEPTACLE * LETTER INDICATES DUPLEX FULLY CONTROLLED RECEPTACLE * FLOOR MOUNTED DUPLEX RECEPTACLE FLOOR MOUNTED BOX

POWER OUTLET - SEE PLANS FOR NEMA TYPE★ **POWER POLE** WALL TELEPHONE OUTLET ** VOICE/DATA WALL OUTLET★

VOICE/DATA OUTLET MOUNTED ABOVE COUNTER - FIELD VERIFY HEIGHT SURFACE MOUNTED VOICE/DATA WALL OUTLET * SURFACE MOUNTED VOICE/DATA OUTLET MOUNTED ABOVE COUNTER - FIELD VERIFY HEIGHT WIRELESS ACCESS POINT (WAP) **CEILING MOUNTED** WIRELESS ACCESS POINT (WAP)

WALL MOUNTED - FIELD VERIFY HEIGHT VOICE/DATA OUTLET - FLOOR MOUNTED TV OUTLET * VOICE/DATA OUTLET - CEILING MOUNTED

INTERIOR SPEAKERS CEILING MOUNTED INTERIOR SPEAKERS WALL MOUNTED CLOCK +8'-0" AFF U.O.N. VERIFY BEFORE

INSTALLATION WALL SWITCH OCCUPANCY SENSOR **

NORMALLY OPEN CONTACT NORMALLY CLOSED CONTACT TRANSFORMER - SEE SINGLE LINE FOR SIZE **PULLBOX** FLEX CONDUIT WITH CONNECTION CONDUIT - UP CONDUIT - DOWN E — CONDUIT EMERGENCY SYSTEM LOW VOLTAGE WIRING SURFACE METAL OR NON-METALLIC RACEWAY CONDUIT - CONCEALED IN WALLS OR CEILING ----- CONDUIT - EXISTING ---- CONDUIT - BELOW SLAB OR UNDERGROUND: 3/4"MIN.

> CAPPED OR STUB-OUT CONDUIT CONDUIT CONTINUATION CONDUIT - HOME RUN TO PANEL. TERMINAL CABINET, ETC. RUNS MARKED WITH CROSSHATCHES INDICATE NUMBER OF #12 AWG WIRES WHEN MORE THAN TWO. SIZE CONDUIT ACCORDING TO SPECIFICATIONS AND APPLICABLE CODE. CROSS HATCHES

WITH NUMBER ADJACENT INDICATES WIRE SIZE OTHER THAN #12 AWG. SHEET NOTE REFERENCE SYMBOL; SEE ASSOCIATED NOTE ON SAME SHEET

SCHEDULE SYMBOL; SEE ASSOCIATED NOTE ON SAME SHEET

DETAIL NOTE REFERENCE SYMBOL SEE ASSOCIATED NOTE ON SAME DETAIL

FEEDER DESIGNATION; FXXX SEE ASSOCIATED NOTE ON SAME DETAIL

ABBREVIATIONS

ALUM/AL

ARCH

AWG

BKR

CATV

CCTV

CKT

EM

ΕV

ERMS

FLUOR

FUTURE

GENERAL CONTRACTOR

CB

DETAIL OR SECTION REFERENCE (X.XX) ➤ SHEET NUMBER

INDICATES QUANTITY OF TELEPHONE OUTLETS — INDICATES QUANTITY OF DATA OUTLETS

AMPERE NOT TO SCALE **GROUND FAULT** ABOVE FINISHED FLOOR OVERALL HEIGHT INTERRUPTING ALUMINUM GND, G ON CENTER GROUND ARCHITECT GALVANIZED RIGID OVERHEAD AMERICAN WIRE STFFL OFCI OWNER FURNACED GAUGE **HEIGHT** CONTRACTOR INSTALLED INTERCOM BREAKER PUBLIC ADDRESS **INTERMEDIATE** CONDUIT PULL BOX DISTRIBUTION FRAME CABLE TV POWER FACTOR CIRCUIT BREAKER **INCANDESCENT CLOSED CIRCUIT TV** JUNCTION BOX PASSIVE INFRARED CIRCUIT ΚV KII OVOI T PANFI CENTER LINE KILOVOLT AMPERES PHOTOVOLTAIC CEILING KII OWATT ΚW POLYVINY CONDUIT ONLY LIGHTING CONTROL LCP CHI ORIDE CENTER POWER LTG LIGHTING RELOCATE DIMMER LOW VOLTAGE REMOVABLE POLI DIMENSION RECPT'S RECEPTACLES THOUSAND DISTRIBUTION CIRCULAR MILS REQD REQUIRED EXISTING REQMT'S REQUIREMENT(S) ELECTRICAL CONTRACTOR M.B. MAIN CIRCUIT BREAKER SHFFT **EVENING LIGHT** MINIMUM MCA SINGLE LINE DIAGRAM CIRCUIT AMPS **EMERGENCY** STC SYSTEMS TERMINATION MDF MAIN DISTRIBUTION FRAME **ELECTRICAL** CABINET **MECHANICAL** METALLIC TUBING **SWITCH** METAL HALIDE **ENERGY REDUCTION** SWBD SWITCHBOARD MAIN LUGS ONLY MAINTENANCE SWITCH TELEPHONE TERMINAL TTB MPOF MAIN POINT OF ENTRANCE BACKBOARD EQUIPMENT MOUNTED **TYPICAL** MOUNTING ELECTRICAL VEHICLE MTG UNLESS OTHERWISE NOTED UON MAXIMUM OVFR FIRE ALARM UNDERGROUND UG CURRENT PROTECTION FIRE ALARM CONTROL PANE **VOLTAGE DROP** NOT IN CONTRACT FOOT CANDLE NOT IN ELECTRICAL WITH CONTRACT **FLOOR** WEATHERPROOF **NIGHT LIGHT FULL LOAD AMPS** XFMR TRANSFORMER NO. NUMBEE FLUORESCENT

> ★+15" A.F.F. TO BOTTOM OF BOX, U.O.N. ** +48" A.F.F. TO TOP OF BOX, U.O.N. [#] NUMBER IN BRACKETS DENOTES NUMBER

> > OF CABLE DROPS WHEN MORE THAN (2).

GENERAL DEMOLITION NOTES

- A. CONTRACTOR SHALL FIELD VERIFY EXTENT OF ELECTRICAL DEMOLITION AND QUANTITIES OF ELECTRICAL TO BE REMOVED AS DICTATED BY THE REQUIREMENTS OF THE PROJECT.
- B. REMOVAL SHALL INCLUDE WIRING, RACEWAY, BOXES, SWITCHES, LIGHT FIXTURES, ETC, AS INDICATED ON THE PLANS AND AS REQUIRED BY THESE DEMOLITION NOTES.
- C. RACEWAYS ASSOCIATED WITH ELECTRICAL BEING DEMOLISHED WHICH ARE CONCEALED IN EXISTING REMAINING WALLS MAY BE ABANDONED IN PLACE. REMOVE WIRING FROM CONDUIT.
- D. RACEWAYS ASSOCIATED WITH ELECTRICAL BEING DEMOLISHED WHICH ARE EXPOSED SHALL

E. WHERE REMOVAL OF EQUIPMENT OR WIRING IS INDICATED, IT SHALL INCLUDE ALL ASSOCIATED

WIRING BACK TO LAST ACTIVE REMAINING OUTLET, DEVICE, FIXTURE OR PANEL. F. ELECTRICAL CONTRACTOR SHALL INSURE THAT ALL REMAINING ACTIVE CIRCUITS, DEVICES, OUTLETS, LIGHT FIXTURES, ETC. HAVE NOT BEEN DISCONNECTED OR MADE INOPERATIVE

DURING DEMOLITION. ELECTRICAL CONTRACTOR SHALL RESTORE ALL INTERRUPTED OR

- DISCONNECTED CIRCUITS TO OPERATION. G. ELECTRICAL CONTRACTOR SHALL REMOVE AND DISPOSE OF ALL REMOVED ELECTRICAL
- EQUIPMENT AND MATERIAL. H. NO REMOVED EQUIPMENT OR MATERIAL SHALL BE REUSED AS PART OF NEW WORK, U.O.N.
- EXISTING REMAINING CONCEALED RACEWAYS MAY BE REUSED FOR NEW WORK PROVIDED
- THEY MEET ALL REQUIREMENTS OF THE SPECIFICATION FOR NEW WORK. J. EXISTING FLUSH OUTLETS MAY BE REUSED FOR NEW WORK PROVIDED THEY MEET ALL REQUIREMENTS OF THE SPECIFICATION FOR NEW WORK, MEET THE REQUIREMENTS OF THE
- K. EXISTING WIRING SHOWN HAS BEEN TAKEN FROM OLD PLANS AND IS ASSUMED TO BE CORRECT. ELECTRICAL CONTRACTOR SHALL FIELD VERIFY ACTUAL CONDITIONS AND MAKE

CURRENT C.E.C. FOR VOLUME AND COINCIDE WITH LOCATION SHOWN FOR THE NEW WORK.

- ADJUSTMENTS TO SUIT ACTUAL CONDITIONS AND TO MEET THE INTENT OF THE CONTRACT DOCUMENTS.
- COORDINATE WITH OWNER PRIOR TO START OF DEMOLITION TO MINIMIZE POWER INTERRUPTIONS, WORK MAY HAVE TO OCCUR DURING NON-REGULAR BUSINESS HOURS. COORDINATE IN WRITING WITH OWNER ONE WEEK PRIOR TO PLANNED POWER INTERRUPTIONS.

EQUIPMENT ANCHORAGE

M/E/P COMPONENT ANCHORAGE NOTES:

ALL MECHANICAL, PLUMBING, AND ELECTRICAL COMPONENTS SHALL BE ANCHORED AND INSTALLED PER THE DETAILS ON THE DSA-APPROVED CONSTRUCTION DOCUMENTS. THE FOLLOWING COMPONENTS SHALL BE ANCHORED OR BRACED TO MEET THE FORCE AND DISPLACEMENT REQUIREMENTS PRESCRIBED IN THE 2022 CBC SECTIONS 1617A.1.18 THROUGH 1617A.1.26 AND ASCE 7-16 CHAPTERS 13, 26, AND 30:

ALL PERMANENT EQUIPMENT AND COMPONENTS.

CORNER MOUNTED

DIMMER ROOM CONTROLLER

ROOM LIGHTING CONTROLLER

LIGHTING CONTROL PANEL

DIGITAL DAYLIGHT SENSOR

SINGLE POLE SWITCH **

SINGLE POLE SWITCH, **

THREE WAY SWITCH**

FOUR WAY SWITCH**

LIGHTING DIMMER**

DIGITAL MULTI SCENE

MANUAL MOTOR STARTER

KEY OPERATED SWITCH **

DIGITAL ON/OFF SWITCH **

DIGITAL DIMMER SWITCH **

DIGITAL DUAL TECHNOLOGY

WALL OCCUPANCY SENSOR **

DIMMING DUAL TECHNOLOGY

DOUBLE SWITCHED WALL OCCUPANCY

WALL SWITCH OCCUPANCY SENSOR **

2-BUTTON DIMMING DUAL TECHNOLOGY

WALL OCC. SENSOR **

SENSOR **

a = CIRCUIT CONTROLLED

PLUG LOAD CONTROLLER

- TEMPORARY, MOVABLE OR MOBILE EQUIPMENT THAT IS PERMANENTLY ATTACHED (e.g. HARD WIRED) TO THE BUILDING UTILITY SERVICES SUCH AS ELECTRICITY, GAS OR WATER. "PERMANENTLY ATTACHED" SHALL INCLUDE ALL ELECTRICAL CONNECTIONS EXCEPT PLUGS FOR 110 / 220 VOLT RECEPTACLES HAVING A FLEXIBLE CABLE.
- TEMPORARY, MOVABLE OR MOBILE EQUIPMENT WHICH IS HEAVIER THAN 400 POUNDS OR HAS A CENTER OF MASS LOCATED 4 FEET OR MORE ABOVE THE ADJACENT FLOOR OR ROOF LEVEL THAT DIRECTLY SUPPORT THE COMPONENT IS REQUIRED TO BE RESTRAINED IN A MANNER APPROVED BY DSA.

THE FOLLOWING MECHANICAL AND ELECTRICAL COMPONENTS SHALL BE POSITIVELY ATTACHED TO THE STRUCTURE, BUT NEED NOT BE DETAILED IN THE PLANS. THESE COMPONENTS SHALL HAVE FLEXIBLE CONNECTIONS PROVIDED BETWEEN THE COMPONENT AND ASSOCIATED DUCTWORK, PIPING AND CONDUIT. FLEXIBLE CONNECTIONS MUST ALLOW MOVEMENT IN BOTH TRANSVERSE AND LONGITUDINAL DIRECTIONS.

- COMPONENTS WEIGHTING LESS THAN 400 POUNDS AND HAVE A CENTER OF MASS LOCATED 4 FEET OR LESS ABOVE THE ADJACENT FLOOR OR ROOF LEVEL THAT DIRECTLY SUPPORT THE COMPONENT.
- COMPONENTS WEIGHTING LESS THAN 20 POUNDS, OR IN THE CASE OF DISTRIBUTED SYSTEMS, LESS THAN 5 POUNDS PER FOOT, WHICH ARE SUSPENDED FROM A ROOF OR FLOOR OR HUNG FROM A WALL.

THE ANCHORAGE OF ALL MECHANICAL, ELECTRICAL AND PLUMBING COMPONENTS SHALL BE SUBJECT OF THE APPROVAL OF THE DESIGN PROFESSIONAL IN GENERAL RESPONSIBLE CHARGE OR STRUCTURAL ENGINEER DELEGATED RESPONSIBILITY AND ACCEPTANCE BY DSA. THE PROJECT INSPECTOR WILL VERIFY THAT ALL COMPONENTS AND EQUIPMENT HAVE BEEN ANCHORED IN ACCORDANCE WITH ABOVE REQUIREMENTS.

PIPING, DUCTWORK AND ELECTRICAL DISTRIBUTION SYSTEM BRACING NOTE

PIPING, DUCTWORK AND ELECTRICAL DISTRIBUTION SYSTEMS SHALL BE BRACED TO COMPLY WITH THE FORCES AND DISPLACEMENTS PRESCRIBED IN ASCE 7-16 SECTION 13.3 AS DEFINED IN ASCE 7-16 SECTION 13.6.5, 13.6.6, 13.6.7, 13.6.8 AND 2022 CBC, SECTIONS 1617A.1.24, 1617A.1.25 AND 1617A.1.26.

THE METHOD OF SHOWING BRACING AND ATTACHMENTS TO THE STRUCTURE FOR THE IDENTIFIED DISTRIBUTION SYSTEM ARE AS NOTED BELOW. WHEN BRACING AND ATTACHMENTS ARE BASED ON PRE-APPROVED INSTALLATION GUIDE (e.g. HCAI OPM FOR 2013 CBC OR LATER), COPIES OF THE BRACING SYSTEM INSTALLATION GUIDE OR MANUAL SHALL BE AVAILABLE ON THE JOBSITE PRIOR TO THE START OF AND DURING THE HANGING AND BRACING OF THE DISTRIBUTION SYSTEMS. THE STRUCTURAL ENGINEER OF RECORD SHALL VERIFY THE ADEQUACY OF THE STRUCTURE TO SUPPORT THE HANGER AND BRACE LOADS.

MECHANICAL PIPING (MP), MECHANICAL DUCTS (MD), PLUMBING PIPING (PP), ELECTRICAL DISTRIBUTION SYSTEMS (E):

MP ☐ MD ☐ PP ☐ E ■ - OPTION 1: DETAILED ON THE APPROVED DRAWINGS WITH PROJECT SPECIFIC NOTES AND

MP ☐ MD ☐ PP ☐ E ☐ - OPTION 2: SHALL COMPLY WITH THE APPLICABLE HCAI PRE-APPROVED (OPM #)

- 1. 2022 CALIFORNIA ADMINISTRATIVE CODE C.A.C., PART 1, TITLE 24, C.C.R.
- 2022 CALIFORNIA BUILDING CODE (CBC) C.C.R., TITLE 24, VOL. 1 & 2 BASED ON THE 2021 INTERNATIONAL BUILDING CODE (IBC) WITH CALIFORNIA AMENDMENTS.
- 2022 CALIFORNIA ELECTRICAL CODE (CEC) C.C.R., TITLE 24, PART 3 BASED ON THE
- 2020 NATIONAL ELECTRICAL CODE (NEC) WITH CALIFORNIA AMENDMENTS. 4. 2022 CALIFORNIA MECHANICAL CODE (CMC) C.C.R., TITLE 24, PART 4 BASED ON THE
- 2021 UNIFORM MECHANICAL CODE (UMC) WITH CALIFORNIA AMENDMENTS.
- 2022 CALIFORNIA PLUMBING CODE (CPC) C.C.R., TITLE 24, PART 5 BASED ON THE 2021 UNIFORM PLUMBING CODE (UPC) WITH CALIFORNIA AMENDMENTS.
- 6. 2022 CALIFORNIA ENERGY CODE C.C.R., TITLE 24, PART 6.
- 2022 CALIFORNIA FIRE CODE (CFC) C.C.R., TITLE 24, PART 9 BASED ON THE 2021 INTERNATIONAL FIRE CODE (IFC) WITH CALIFORNIA AMENDMENTS.
- 8. 2022 CALIFORNIA GREEN BUILDING STANDARDS CODE C.C.R., TITLE 24, PART 11.
- 9. 2022 CALIFORNIA REFERENCED STANDARDS CODE C.C.R., TITLE 24, PART 12.
- 10. TITLE 19 C.C.R., PUBLIC SAFETY, STATE FIRE MARSHAL REGULATIONS.
- 11. NATIONAL FIRE ALARM CODE (NFPA 72) 2022.

STANDARDS:

- AMERICAN NATIONAL STANDARDS INSTITUTE (ANSI)
- 2. ELECTRONICS INDUSTRIES ASSOCIATION (EIA)
- 3. INSTITUTE OF ELECTRICAL AND ELECTRONIC ENGINEERS (IEEE)
- 4. NATIONAL ELECTRICAL MANUFACTURERS ASSOCIATION (NEMA)
- 5. NATIONAL ELECTRICAL TESTING ASSOCIATION (NETA)
- 6. UNDERWRITER LABORATORIES (UL)
- 7. CALIFORNIA OCCUPATIONAL SAFETY AND HEALTH ACT STANDARDS (CAL/OSHA)

SHEET INDEX

NOM

NOMINAL

- E001 SYMBOLS, ABBREVIATIONS, GENERAL CONSTRUCTION NOTES, LIGHT FIXTURE SCHEDULE, CODES & SHEET
- E101 ELECTRICAL SINGLE LINE DIAGRAM & DETAILS.
- E201 OVERALL SITE PLAN.
- E202 PARTIAL SITE PLAN.

Project Title

Engineer Seal

Architect Seal

LAKESIDE

Regulatory Agency Approval

IDENTIFICATION STAMP DIV. OF THE STATE ARCHITEC

REVIEWED FOR

SS 🗹 FLS 🗹 ACS 🗌

3/20/2025

APP: 01-122102 INC:

DSA: 01 -122102 / File: 43-25

McKim Design Group

4595 Cherry Avenue, First Floor, San Jose, CA 95118

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MONTEREY BAY. INC

Project No. 24-243.00

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ENGINEERS, INC., AND VISUAL CONTACT WITH THEM CONSTITUTES PRIMA

FACIE EVIDENCE OF THE ACCEPTANCE OF THESE RESTRICTIONS

ELEMENTARY SCHOOL

19621 Black Road

Los Gatos, CA 95033 **EMERGENCY GENERATOR**

INFRASTRUCTURE

LAKESIDE JOINT SCHOOL DISTRICT 19621 Black Road Los Gatos, CA 95033

Revisions/Submissions

.,,	1 to the letter of a strine of other	Date
	DSA Submittal V1	12/11/2024
	DSA Submittal V2	3/11/2025

SYMBOLS, ABBREVIATIONS, GENERAL CONSTRUCTION NOTES, CODES & SHEET INDEX

Project No.


Drawing Title

October 10, 2024 Drawing Number

Date

E001


APPLICABLE CODES & STANDARDS

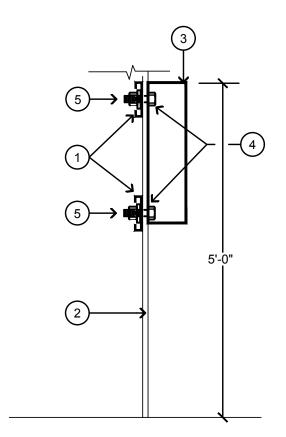

DETAIL NOTES:


- 1. 16 GA. "C" SHAPE BLOCKING BEHIND SWITCHBOARD AT FASTENER LOCATIONS. BLOCK FLANGES AND FASTEN WEB OF 20 GA. BLOCK TO FLANGE OF TYPICAL STUDS - (2) #6 EA.
- 2. METAL SWITCHBOARD ENCLOSURE
- 3. PULLCAN (WEIGHT 60 LBS MAX).
- 4. ½" DIA x 3" LONG BOLT AT BACK CORNER; TYPICAL (4) PER PULLCAN AT
- 5. FLAT WASHER & ½" NUT.

SURFACE MOUNTED PULLCAN

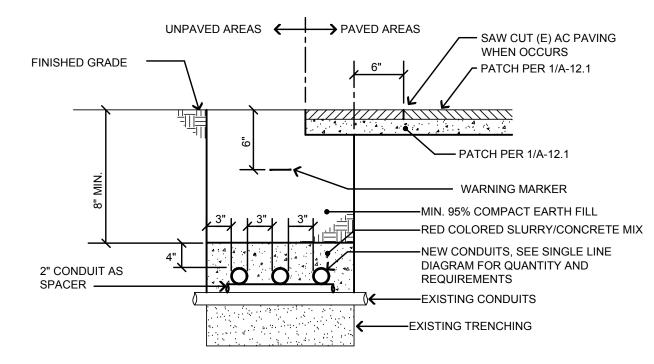

TRENCH SECTION AT CONDUIT CROSSING

NO SCALE

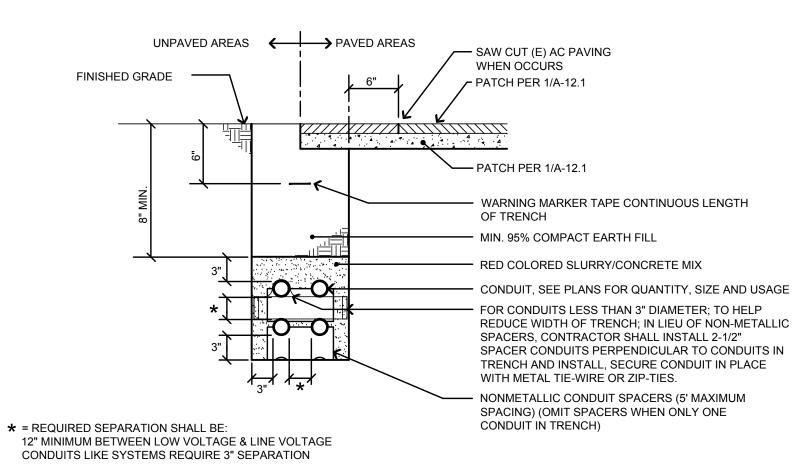

NOTES FOR CLEARANCES:


- THE MINIMUM RECOMMENDED SEPARATIONS BETWEEN TELECOMMUNICATIONS CONDUIT SYSTEMS AND OUTSIDE SURFACES OF FOREIGN STRUCTURES VARY IN ACCORDANCE WITH REGIONAL STANDARDS, CODES, AND
 - a. 6" MIN. WHEN CROSSING PIPES (E.G., GAS, WATER, OIL)
 - 12" MIN. WHEN PARALLEL TO PIPES (E.G., GAS, WATER, OIL) 3" MIN. CONCRETE FOREIGN CONDUIT (POWER OR OTHER)
- 4" MIN. MASONRY (POWER OR OTHER) e. 12" MIN. OF WELL-TAMPED EARTH (POWER OR OTHER)
- THE TOP OF CONDUIT SHOULD BE LOCATED AT A SUFFICIENT DEPTH (NORMALLY 24"-30") BELOW SURFACE GRADE SO BOTH LIVE OR DYNAMIC AND DEAD (STATIC) OR EARTH LOADS CAN BE SUSTAINED BY THE CONDUIT STRUCTURE.

NOTES:

- SAW CUT, TRENCH & BACKFILL FOR NEW CONDUITS. PATCH WALKWAY TO MATCH (E) SURROUNDING SURFACES. CARE SHALL BE TAKEN TO PROTECT EXISTING TREES. RESEED OR RESOD (E) DISTURBED PLANTED AREAS TO ARCHITECT'S SATISFACTION.
- BASE MATERIAL TO BE REPLACED TO THE DEPTH OF EXISTING BASE 6" MINIMUM AND COMPACTED TO A MIN. 95% RELATIVE COMPACTION. A.C. MAY BE SUBSTITUTED FOR BASE MATERIAL. WHEN USED AS BACKFILL, CLASS 100-E-100 P.C.C. MAY BE SUBSTITUTED FOR BASE MATERIAL.

TYPICAL TRENCH SECTION

DETAIL NOTES:

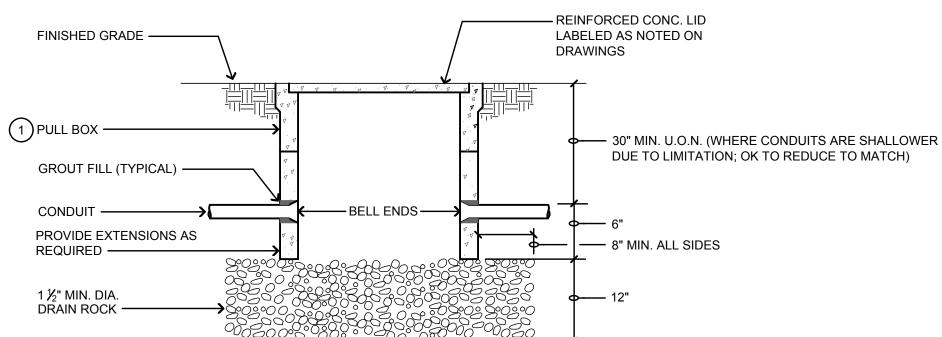

TYPICAL PULLBOX DETAIL

SOLAR L DISCONNECT

DETAIL NOTES:

- 1. DISCONNECT EXISTING SOLAR FROM 100 AMP, 3-POLE BREAKER; COORDINATE WITH DISTRICT SOLAR VENDOR/DISTRICT ELECTRICAL REPRESENTATIVE AND RECONNECT SOLAR AT BUSSING BETWEEN PG&E METER AND MAIN BREAKER.
- SHALL MAINTAIN REQUIRED AIR GAP BETWEEN PHASE AND GROUNDED SURFACES, MAINTAIN BEND RADIUS AND SUPPORT OF CONDUCTORS AND ENSURE REQUIREMENTS OF NEC 240.4 7 240.21 ARE MET.
- 3. INSTALL AND BOLT MECHANICAL LUGS OR COMPRESSION BARREL CONNECTORS TO BUSSING FOR TERMINATION OF FEEDERS TO AND FROM "MTS". NORMAL OUT TO "MTS" SHALL BE INSTALLED AFTER MAIN BREAKER AND BEFORE DISTRIBUTION BUSSING. LOAD SIDE IN FROM "MTS" SHALL BE INSTALLED AT DISTRIBUTION BUSSING TO BACKUP DISTRIBUTION BUSSING TO BACKUP DISTRIBUTION OF EXISTING "MSB".
- 5. INSTALL NEW 20 AMP, 2-POLE BREAKER AND ASSOCIATED MOUNTING HARDWARE. MATCH EXISTING IN RATING AND
- 6. OWNER FURNISHED; CONTRACTOR INSTALLED MANUAL TRANSFER SWITCH; 1200A, 120V/208V, 3-PHASE, 3-POLE TO ARCHITECTURAL PLAN FOR ANCHORAGE OF "MTS",

	FEEDER SCHEDULE				
	DESIGNATION	AMPACITY	CONDUIT & CONDUCTORS SIZES		
	F200	20	3/4"C., 2 #10 & 1 #10 GND.		
	F415	1000	(3) 4" C., EACH W/4 #400kcm & 1 #2/0 GND (PARALLEL).		

SINGLE LINE DIAGRAM LEGEND				
	(DEMOLISH)			
	(EXISTING)			
	(NEW)			
	(E) FLOOR/PAD MOUNTED EQUIPMENT			

ELECTRICAL SINGLE LINE DIAGRAM^L

~ (E) MAIN ELECTRICAL SWITCHBOARD "MSB";

(E) 1000/3

GENERAL NOTE: U.O.N., ALL SHOWN IS NEW.

1000A, 120/208V, 3Ø, 4W, NEMA 3R, 65 KAIC.

F200

(E) 100/3 (1)

Drawing Title

Regulatory Agency Approval

IDENTIFICATION STAMP DIV. OF THE STATE ARCHITEC

REVIEWED FOR SS 🗹 FLS 🗹 ACS 🗌

APP: 01-122102 INC:

DATE: 3/20/2025

DSA: 01 -122102 / File: 43-25

McKim Design Group

4595 Cherry Avenue, First Floor, San Jose, CA 95118 ph. (408) 927-8110 fax (408) 927-8112

AURUM CONSULTING

MONTEREY BAY, INC.

Project No. 24-243.00

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No. E21043 EXP. 3/31/27

LAKESIDE

ELEMENTARY SCHOOL

19621 Black Road

Los Gatos, CA 95033

EMERGENCY GENERATOR

INFRASTRUCTURE

LAKESIDE JOINT SCHOOL DISTRICT

19621 Black Road

Los Gatos, CA 95033

12/11/2024

3/11/2025

Revisions/Submissions

OSA Submittal V1

OSA Submittal V2

Engineer Seal

Architect Seal

Project Title

SINGLE LINE & DETAILS

Project No. October 10, 2024 Drawing Number

E101

1. SIZE(S) & MFGR. AS NOTED ON DRAWINGS.

2. INSTALL TO ALLOW FOR "LINE SIDE" TAP. LINE SIDE TAPS

4. REMOVE BUS LINKS BETWEEN MAIN BREAKER AND DISTRIBUTION SECTIONS.

TYPE. FOR JACKET HEATER OF "MTS" CONNECTION.

WITH SOLID NEUTRAL, 65KAIC. CONTRACTOR SHALL REFER DETAIL 3/A-12.1.

Regulatory Agency Approval

IDENTIFICATION STAMP
DIV. OF THE STATE ARCHITECT

APP: 01-122102 INC:

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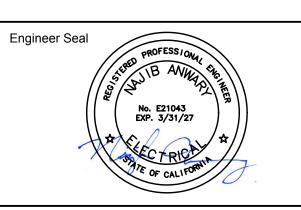
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ENGINEERS
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Architect Seal

Project Title

LAKESIDE ELEMENTARY SCHOOL

19621 Black Road Los Gatos, CA 95033

EMERGENCY GENERATOR INFRASTRUCTURE

Client

LAKESIDE JOINT
SCHOOL DISTRICT
19621 Black Road
Los Gatos, CA 95033

No Revisions/Submissions Date

No	Revisions/Submissions	Date
	DSA Submittal V1	12/11/2024
	DSA Submittal V2	3/11/2025
Drai	ving Title	

Drawing Title

OVERALL SITE PLAN


Project No. Date
2424 October 10, 2024

Drawing Number

T NORTH

SCALE: 1"=30'-0"

E201

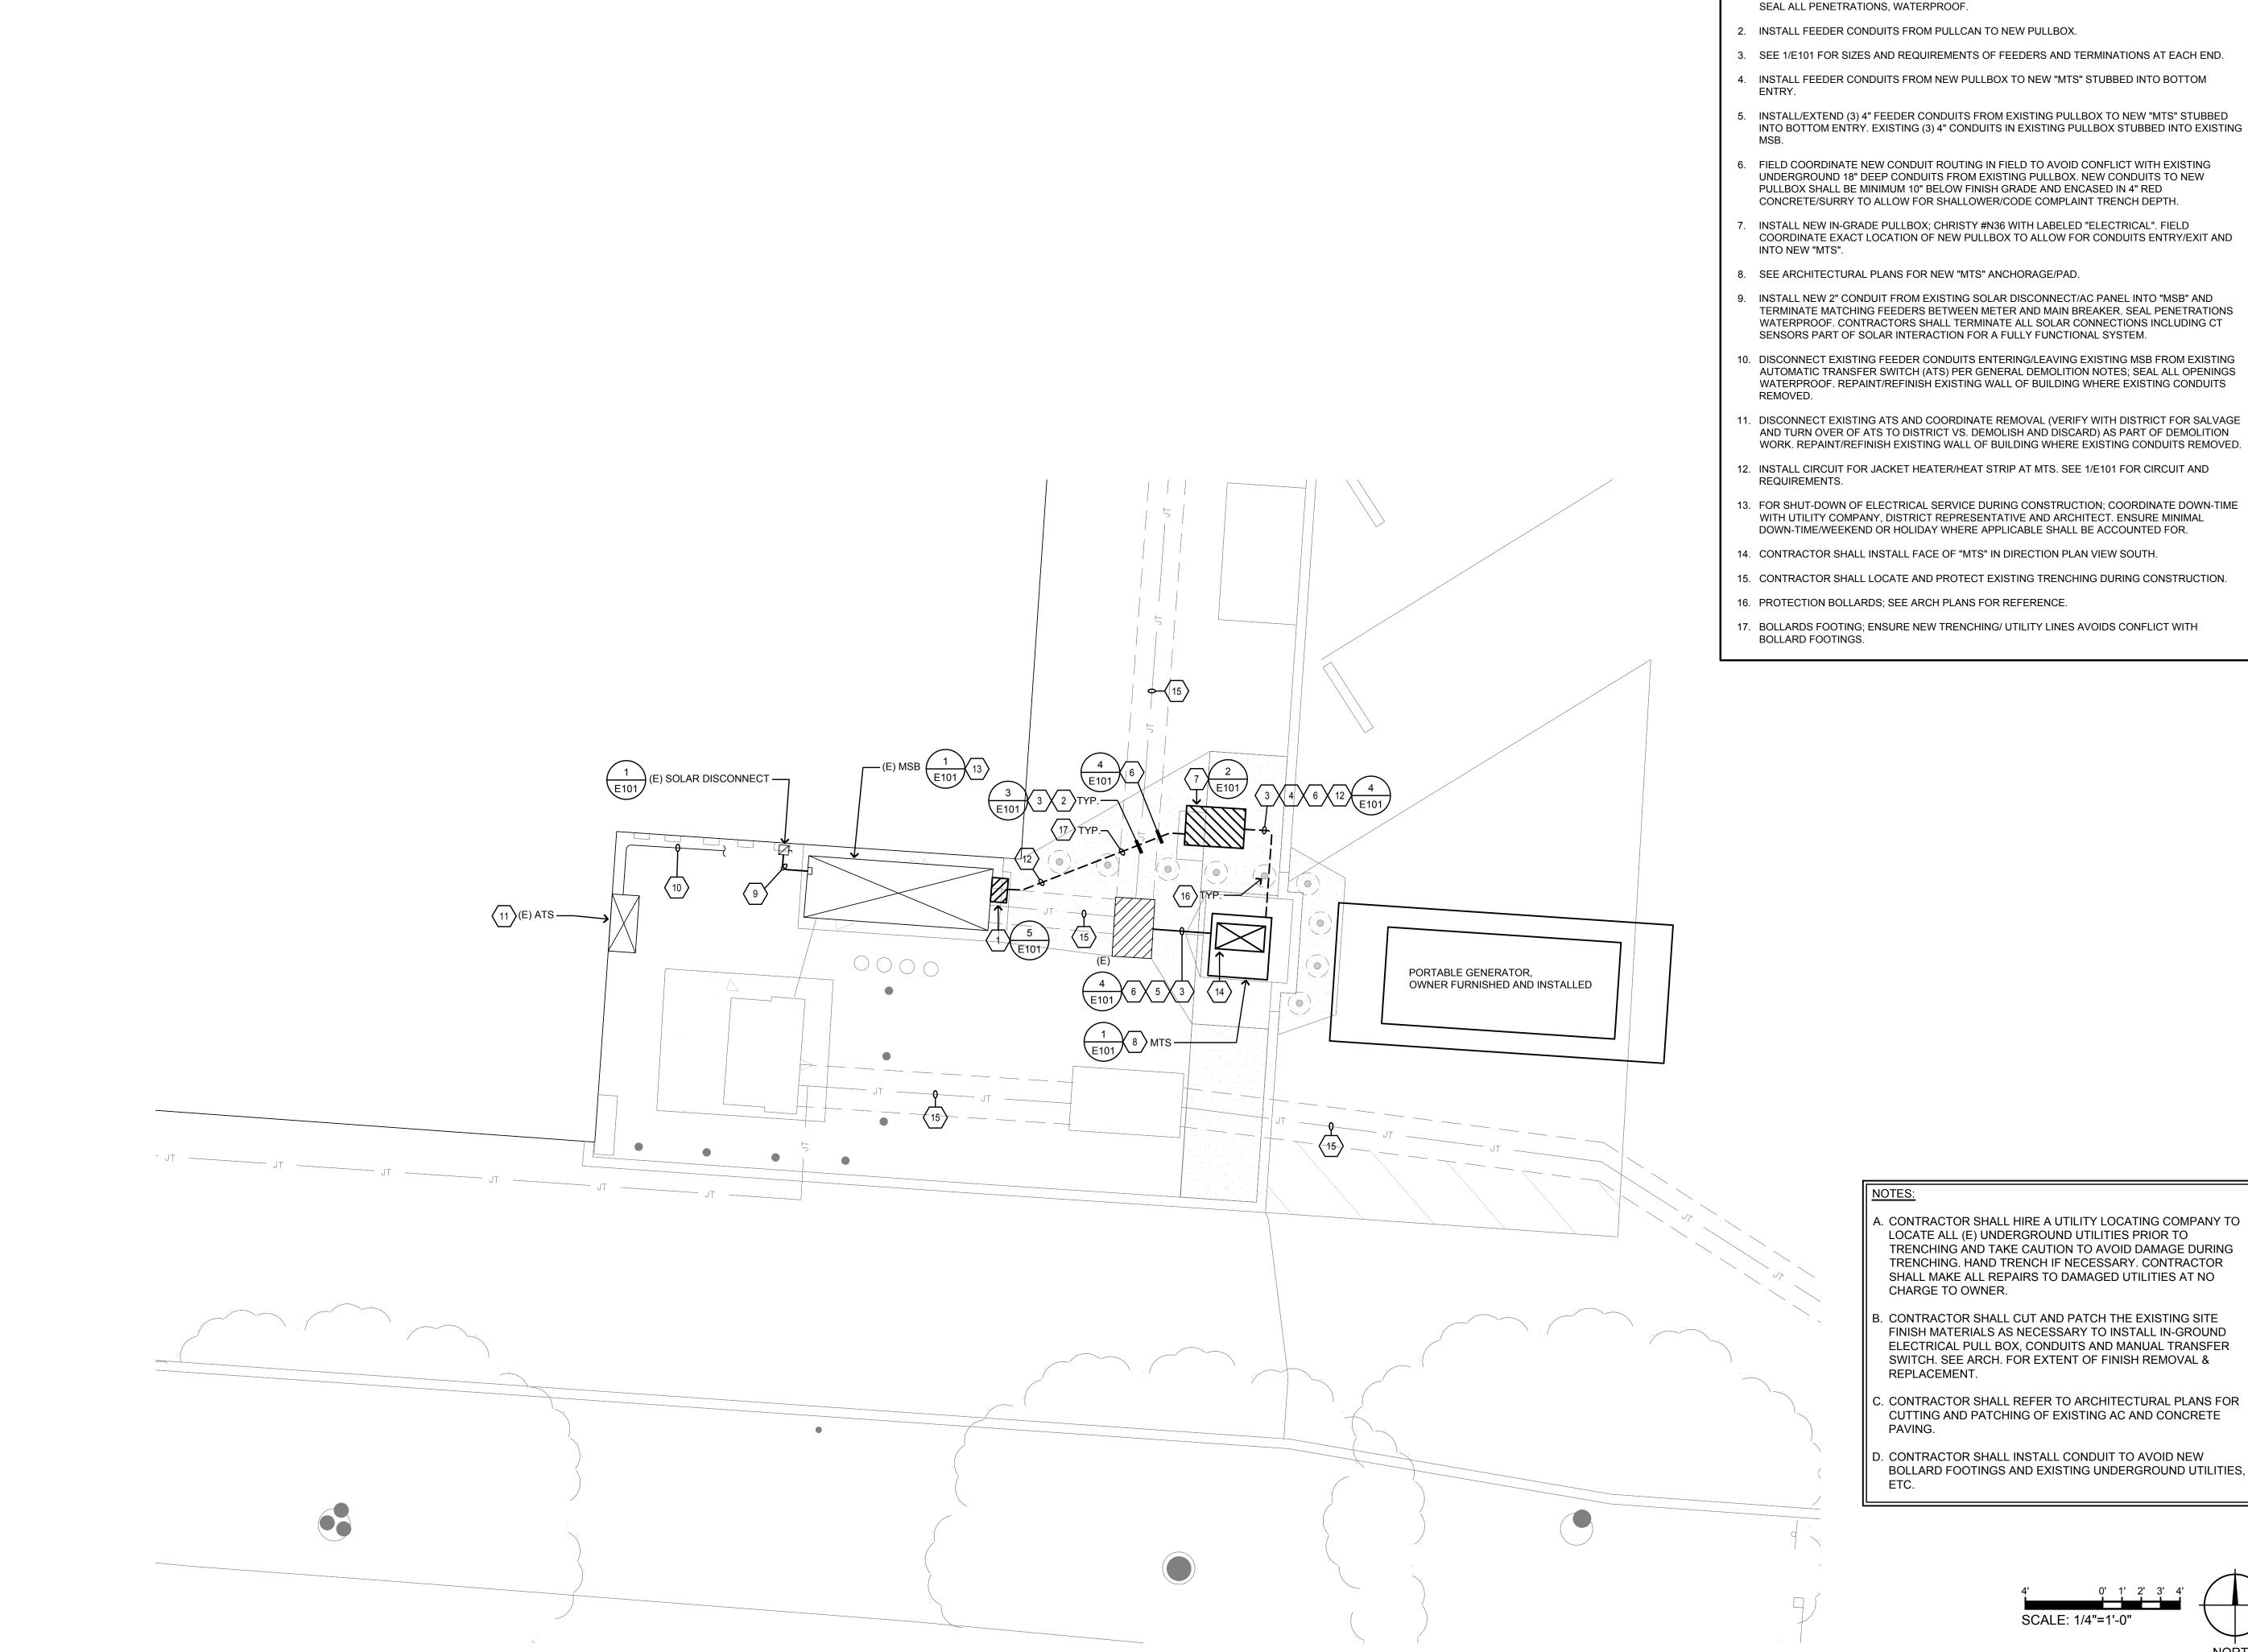

○ SHEET NOTES

- 1. PROVIDE AND INSTALL PULLCAN ON SIDE OF EXISTING "MSB". 30" SQUARE X 18" DEEP, NEMA 3R. SEAL ALL PENETRATIONS, WATERPROOF.
- 2. INSTALL FEEDER CONDUITS FROM PULLCAN TO NEW PULLBOX.
- 3. SEE 1/E101 FOR SIZES AND REQUIREMENTS OF FEEDERS AND TERMINATIONS AT EACH END.
- 4. INSTALL FEEDER CONDUITS FROM NEW PULLBOX TO NEW "MTS" STUBBED INTO BOTTOM
- 5. INSTALL/EXTEND (3) 4" FEEDER CONDUITS FROM EXISTING PULLBOX TO NEW "MTS" STUBBED INTO BOTTOM ENTRY. EXISTING (3) 4" CONDUITS IN EXISTING PULLBOX STUBBED INTO EXISTING
- 6. FIELD COORDINATE NEW CONDUIT ROUTING IN FIELD TO AVOID CONFLICT WITH EXISTING UNDERGROUND 18" DEEP CONDUITS FROM EXISTING PULLBOX. NEW CONDUITS TO NEW PULLBOX SHALL BE MINIMUM 10" BELOW FINISH GRADE AND ENCASED IN 4" RED CONCRETE/SURRY TO ALLOW FOR SHALLOWER/CODE COMPLAINT TRENCH DEPTH.
- 7. INSTALL NEW IN-GRADE PULLBOX; CHRISTY #N36 WITH LABELED "ELECTRICAL". FIELD COORDINATE EXACT LOCATION OF NEW PULLBOX TO ALLOW FOR CONDUITS ENTRY/EXIT AND
- 8. SEE ARCHITECTURAL PLANS FOR NEW "MTS" ANCHORAGE/PAD.
- 9. INSTALL NEW 2" CONDUIT FROM EXISTING SOLAR DISCONNECT/AC PANEL INTO "MSB" AND TERMINATE MATCHING FEEDERS BETWEEN METER AND MAIN BREAKER. SEAL PENETRATIONS WATERPROOF. CONTRACTORS SHALL TERMINATE ALL SOLAR CONNECTIONS INCLUDING CT SENSORS PART OF SOLAR INTERACTION FOR A FULLY FUNCTIONAL SYSTEM.
- 10. DISCONNECT EXISTING FEEDER CONDUITS ENTERING/LEAVING EXISTING MSB FROM EXISTING AUTOMATIC TRANSFER SWITCH (ATS) PER GENERAL DEMOLITION NOTES; SEAL ALL OPENINGS WATERPROOF. REPAINT/REFINISH EXISTING WALL OF BUILDING WHERE EXISTING CONDUITS
- 11. DISCONNECT EXISTING ATS AND COORDINATE REMOVAL (VERIFY WITH DISTRICT FOR SALVAGE AND TURN OVER OF ATS TO DISTRICT VS. DEMOLISH AND DISCARD) AS PART OF DEMOLITION WORK. REPAINT/REFINISH EXISTING WALL OF BUILDING WHERE EXISTING CONDUITS REMOVED.
- 12. INSTALL CIRCUIT FOR JACKET HEATER/HEAT STRIP AT MTS. SEE 1/E101 FOR CIRCUIT AND
- 13. FOR SHUT-DOWN OF ELECTRICAL SERVICE DURING CONSTRUCTION; COORDINATE DOWN-TIME WITH UTILITY COMPANY, DISTRICT REPRESENTATIVE AND ARCHITECT. ENSURE MINIMAL DOWN-TIME/WEEKEND OR HOLIDAY WHERE APPLICABLE SHALL BE ACCOUNTED FOR.
- 14. CONTRACTOR SHALL INSTALL FACE OF "MTS" IN DIRECTION PLAN VIEW SOUTH.
- 15. CONTRACTOR SHALL LOCATE AND PROTECT EXISTING TRENCHING DURING CONSTRUCTION.
- 16. PROTECTION BOLLARDS; SEE ARCH PLANS FOR REFERENCE.
- 17. BOLLARDS FOOTING; ENSURE NEW TRENCHING/ UTILITY LINES AVOIDS CONFLICT WITH

Regulatory Agency Approval

IDENTIFICATION STAMP DIV. OF THE STATE ARCHITECT APP: 01-122102 INC: REVIEWED FOR SS 🗹 FLS 🗹 ACS 🗌 3/20/2025

DSA: 01 -122102 / File: 43-25




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Architect Seal

Project Title

LAKESIDE **ELEMENTARY SCHOOL**

19621 Black Road Los Gatos, CA 95033

EMERGENCY GENERATOR INFRASTRUCTURE

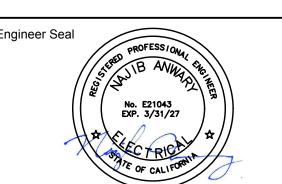LAKESIDE JOINT SCHOOL DISTRICT 19621 Black Road Los Gatos, CA 95033

Revisions/Submissions Date

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Drawing Title

PARTIAL SITE PLAN

October 10, 2024 Drawing Number



NORTH

SCALE: 1/4"=1'-0"

E202